Drain: SPRINGS OF COMBRIDGE CRAIN	Drain #:_ <u>262</u>
Improvement/Arm: SPRINGS OF Come	CURCH-SECTION 4
Operator: <u>JOH</u>	Date: 7-1-04
Drain Classification: Urban/Rural	Year Installed: /994

GIS Drain Input Checklist

- Pull Source Documents for Scanning
- Digitize & Attribute Tile Drains
- Digitize & Attribute Storm Drains
- Digitize & Attribute SSD
- Digitize & Attribute Open Ditch
- Stamp Plans
- Sum drain lengths & Validate
- Enter Improvements into Posse
- Enter Drain Age into Posse
- Sum drain length for Watershed in Posse
- Check Database entries for errors

920

gu ___

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MA _____

gr.

gn

Gasb 34 Footages for Historical Cost <u>Drain Length Log</u>

Drain-Improvement: Spents of Com Brust With - Spents of Cambridge - Stenany

Desir T.		Length SUNATOR	Length	Length	MA IFA	icable /
Drain Type:	Size:	MAGNA	(DB Query)	Reconcile	Price:	Cost:
SSO	6"	8,051,42'	8,051,42	Ø		
RCP	12"	1,127'	1,127'	ø		
	15#	731'	731'	Ø		
	18"	652'	657'	9		
	24"	1431	9431	ø		
	30"	202'	Zoz'	Ø		

		<u> </u>				
	Sum:	11,706,421	11,706,42		_	
inal Report:						
omments:						





Kenton C. Ward, Surveyor Phone (317) 776-8495 Fax (317) 776-9628

Suite 188 One Hamilton County Square Noblesville, Indiana 46060-2230

Map Correction-Field Verification

Drain Number: 296

Drain Length: N/A

Drain Name: Springs of Cambridge
Sec. 4 Acm

Change +/-:0

Date: 1-12-2005

New Length: N/A

Verified By: Jerry Liston - Drainage Inspector

WO - 2004 - 00187

Notes & Sketch:

The work done across lot 97 in the Springs of Cambridged Subdivision was done under maintenance funds by another contractor. The developer paid for the engineering and the topo work. This was approved by the board and can be found in the attached drainage board minutes found in DRB 7, page 489.

The project enclosed 146.7 feet of open drain with 24" RCP. This is shown on the attached asbuilt sheet by Paul I Cripe – project #9601510-30000. The project did not alter the drain's length.

Suzanne L. Mills GIS Specialist

"FINDINGS AND ORDER

CONCERNING THE MAINTENANCE OF THE

Elliott Creek Drain, Village of West Clay Section 5003 Arm

On this 28th day of June, 2004, the Hamilton County Drainage Board has held a hearing on the Maintenance Report and Schedule of Assessments of the Elliott Creek Drain, Village of West Clay Section 5003 Arm.

Evidence has been heard. Objections were presented and considered. The Board then adopted the original/amended Schedule of Assessments. The Board now finds that the annual maintenance assessment will be less than the benefits to the landowners and issues this order declaring that this Maintenance Fund be established.

Christine Altman

HAMILTON COUNTY DRAINAGE BOARD

Presid	ent		- ; · -
<u>Steven</u> Member	A.	Holt	
Steven	C.	Dillinger	

Attest: Lynette Mosbaugh "

RFF Opening - John Osborne Drain, Bridlebourne Subdivision Hydraulic Study:
The following people were present for the RFP opening: Mr. Kent Schuch, Mr. Steve Nelson,
Mr. David Finley and Mr. Brett Quandt.

Howard stated that the following proposals were submitted for RFF opening this morning: Poggemeyer Design Group, Inc.; Earth Tech; Quandt Engineering; Christopher Burke; Consoer Townsend Engineers; American Consulting Engineers; Beam, Longest & Neff and DLZ. This appears to be all the RFPs. Howard asked if any persons know of any other RFPs. No other RFPs appeared. Howard recommended that the RFPs be referred to the Surveyor's Office for review and recommendation at the next Board meeting on July 12, 2004.

Dillinger made the motion to refer the RFPs to the Surveyor's Office, seconded by Holt and approved unanimously.

Springs of Cambridge Drain, Lot 97:

Liston stated that the Surveyor's Office has been working with the developer and the property owner of Lot 97 in the Springs of Cambridge Subdivision to come up with a plan to take care of a severe erosion problem across the rear of Lot 97. The Surveyor's Office has now received the plan. The developer, Marina Limited, paid for the engineering and the topography work associated with that engineering. The office has an estimate from Harvey Construction of \$17,560.00. The Surveyor's Office asks that the Board allow this work to be done on maintenance by Harvey Construction due to the work load that the current maintenance contractor is under.

Altman asked if Harvey Construction is on an approved list of contractors.

Liston stated that Harvey Construction is on an approved list of contractors and is also the developer's contractor that was used exclusively in Springs of Cambridge Subdivision.

Holt made the motion to approve the work to be done by Harvey Construction on maintenance, seconded by Dillinger.

Altman asked if this was the Steven's lot that the Board received a memo on?

Liston stated that Lot 97 is the Steven's lot.

The motion had been made and seconded to approve the work and approved unanimously.

CERTIFICATE OF COMPLETION AND COMPLIANCE

TO: HAMILTON COUNTY SURVEYOR The Springs of Cambridge Subdivision, Section Four RE: Regulated Drain I hereby certify that: I am a Registered Land Surveyor in the State of Indiana, 1.) i am famillar with the plans and specifications for the above referenced 2.) subdivision. 3.) I have personally observed and supervised the completion of the Drainage Facilities for the above referenced subdivision, and To the best of my knowledge, information and belief, the Drainage 4.) Facilities within the subdivision has been installed and completed in conformity with all plans and specifications. October 9, 1995 Type or Printed Name: Joseph A. Sharp Business Address: 7172 Graham Road <u>Indianapolis</u>, IN 46250 Telephone: (317) 842-6777 INDIANA REGISTERED NUMBER S0076



CERTIFICATE OF COMPLETION AND COMPLIANCE

Re: The Springs of Cambridge Subdivision Storm Sewer Improvements on Lot 97

I hereby certify that:

To: Hamilton County Surveyor

- 1. I am a Registered Land Surveyor or Engineer in the State of Indiana.
- 2. I am familiar with the plans and specifications for the above referenced subdivision.
- 3. I have personally observed and supervised the completion of the drainage facilities for the above referenced subdivision.
- 4. The drainage facilities within the above referenced subdivision to the best of my knowledge, information and belief have been installed and completed in conformity with all plans and specifications.

Signature:	pha Sharp Date:	November 29 2004
	JOSEPH A. SHARP	
Business Address:	7172 GRAHAM ROAD	
	INDIANAPOLIS IN	46250
Telephone Number: _	(317) 842-6777	
SEAL	INDIANA REGI	STRATION NUMBER

PE 600 15 179







Kenton C. Ward, Surveyor Phone (317) 776-8495

Fax (317) 776-9628

To: Hamilton County Drainage Board

Suite 146 One Hamilton County Square Noblesville, Indiana 46060+2230

July 7, 1997

Re: Springs of Cambridge - Sec. 4 arm

Attached are as-builts, certificate of completion & compliance, and other information for Springs of Cambridge Sec. 4. An inspection of the drainage facilities for this section has been made and the facilities were found to be complete and acceptable.

During construction, s changes were made to the drain whic will alther the plans ubmitted with my report dated April 18, 1996. The changes are as follows: Str 814-808 12" RCP was reprted as 90' feet in length. This structure is now 89' feet in length. The 6" SSD between lots 174 and 175 was not installed.

11706,42

Therefore, the length of the drain due to the changes described above is now 11,556.42.

The non-enforcement was approved by the Board at its meeting on June 10, 1996 and recorded under instrument #9609634466.

The bond or letter of credit from NBD Bank, number S036608 for storm sewers; S036649 for erosion control; and S306607 for monumentation, dated July 15, 1995 and August 15, 1995, in the amount of \$225,520.00; \$15,000.00; and \$3,000.00, has expired.


I recommend the Board approve the drains construction as complete and acceptable.

Sincerely,

Hamilton County Surveyor

KCW/slm

CONSTRUCTION PLANS FOR THE SPRINGS OF CAMBRIDGE SUBDIVISION SECTIONS THREE AND FOUR

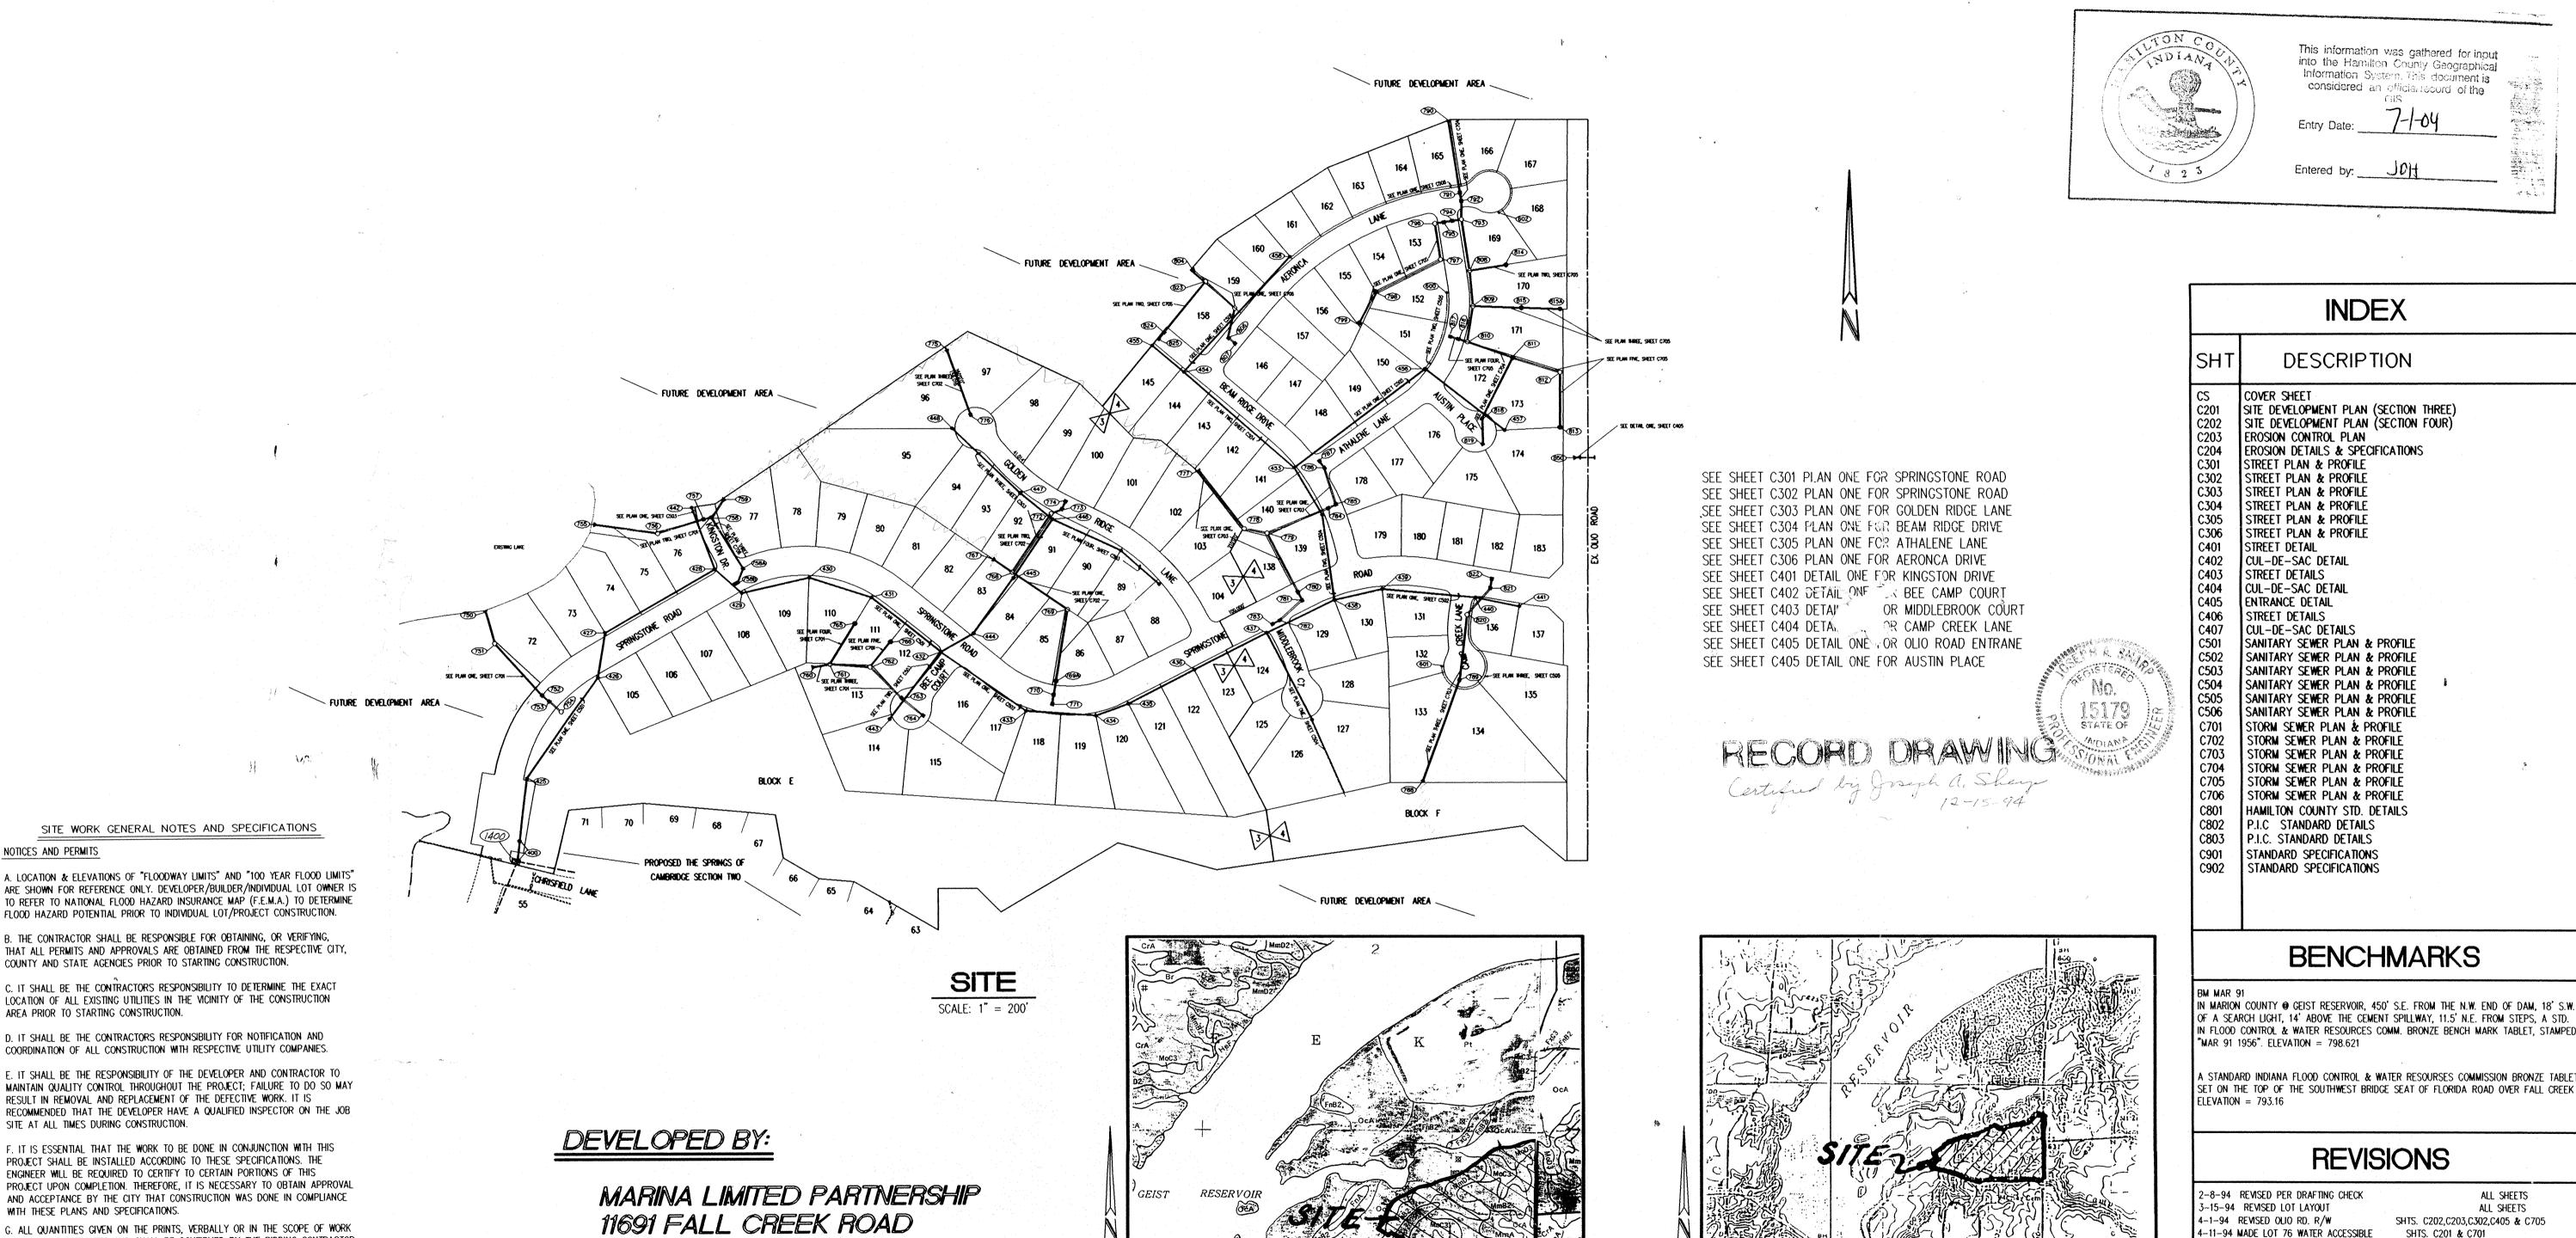

MmA=Miami silt loam MoD3=Miami clay loam MmB2=Miami silt loam MoC3=Miami clay loam AmD2=Miami silt loam CrA=Crosby silt loam



CERTIFIED BY: 8.9.94 DATE

NOTICES AND PERMITS

AREA PRIOR TO STARTING CONSTRUCTION.

SITE AT ALL TIMES DURING CONSTRUCTION.

WITH THESE PLANS AND SPECIFICATIONS.

ABOVE STATED REQUIREMENTS.

EXCAVATIONS EXCEEDING FIVE (5) FEET IN DEPTH.

SECTION ARE ESTIMATES AND SHALL BE CONFIRMED BY THE BIDDING CONTRACTOR.

H. OCCUPATIONAL SAFETY AND HEALTH ADMINISTRATION (OSHA) STANDARDS FOR

I. IN ADDITION, EXCAVATIONS EXCEEDING TWENTY (20) FEET IN DEPTH REQUIRE THE

DESIGN OF A TRENCH SAFETY SYSTEM BY A REGISTERED PROFESSIONAL ENGINEER.

REVISIONS

IT SHALL BE THE RESPONSIBILITY OF THE CONTRACTOR TO COMPLY WITH THE

EXCAVATIONS; FINAL RULE 29 CFR PART 1926, SUBPART "P" APPLIES TO ALL

INDIANAPOLIS, INDIANA 46256

PAUL I. CRIPE, INC.

INDIANAPOLIS, INDIANA 46250 (317) 842-6777

• CIVIL ENGINEERING CONCEPT CHK: DRAWN BY: RIS LAND SURVEYING ARCHITECTURE ENG. CHK: DRFTNG. CHK: LAND PLANNING

SCALE: DATE: AS NOTED DRAWING TITLE:

MARINA LIMITED PARTNERSHIP 8-28-93 COVER SHEET

AREA MAP

OFFICE OF HAMILTON COUNTY SURVEYOR FILE NUMBER

INDEX

DESCRIPTION

SITE DEVELOPMENT PLAN (SECTION THREE

SANITARY SEWER PLAN & PROFILE SANITARY SEWER PLAN & PROFILE

Sanitary sewer plan & profile SANITARY SEWER PLAN & PROFILE SANITARY SEWER PLAN & PROFILE Sanitary sewer plan & profili STORM SEWER PLAN & PROFILE STORM SEWER PLAN & PROFILE STORM SEWER PLAN & PROFILI STORM SEWER PLAN & PROFILE

STORM SEWER PLAN & PROFILI STORM SEWER PLAN & PROFILE HAMILTON COUNTY STD. DETAILS P.I.C STANDARD DETAILS

P.I.C. STANDARD DETAILS

STANDARD SPECIFICATIONS STANDARD SPECIFICATIONS

BENCHMARKS

REVISIONS

4-20-94 ADDED LEVELING COURSE TO OLIO RD. PER HAM. CO. HIGHWAY

8-5-94 MISC. REVISIONS PER HAM. CO. SURVEYOR'S COMMENTS SHT. C201

12-5-94 AS BUILT SAN. SEWERS SHTS. C501-C506

12-14-94 AS BUILT SAN. LATERALS SHTB. C501-C506 12-22-94 AS BUILT STORM BEWERS SHIS C701-C706

SHEET: 2974 JOB NUMBER 81100-22000

ALL SHEETS

ALL SHEETS

SHTS. C202,C203,C302,C405 & C705


SHTS. C201,C203,C301 & C501


SHTS. CS,C201,C202,C701,C703,C705,C706 & C802


SHTS. C201 & C701





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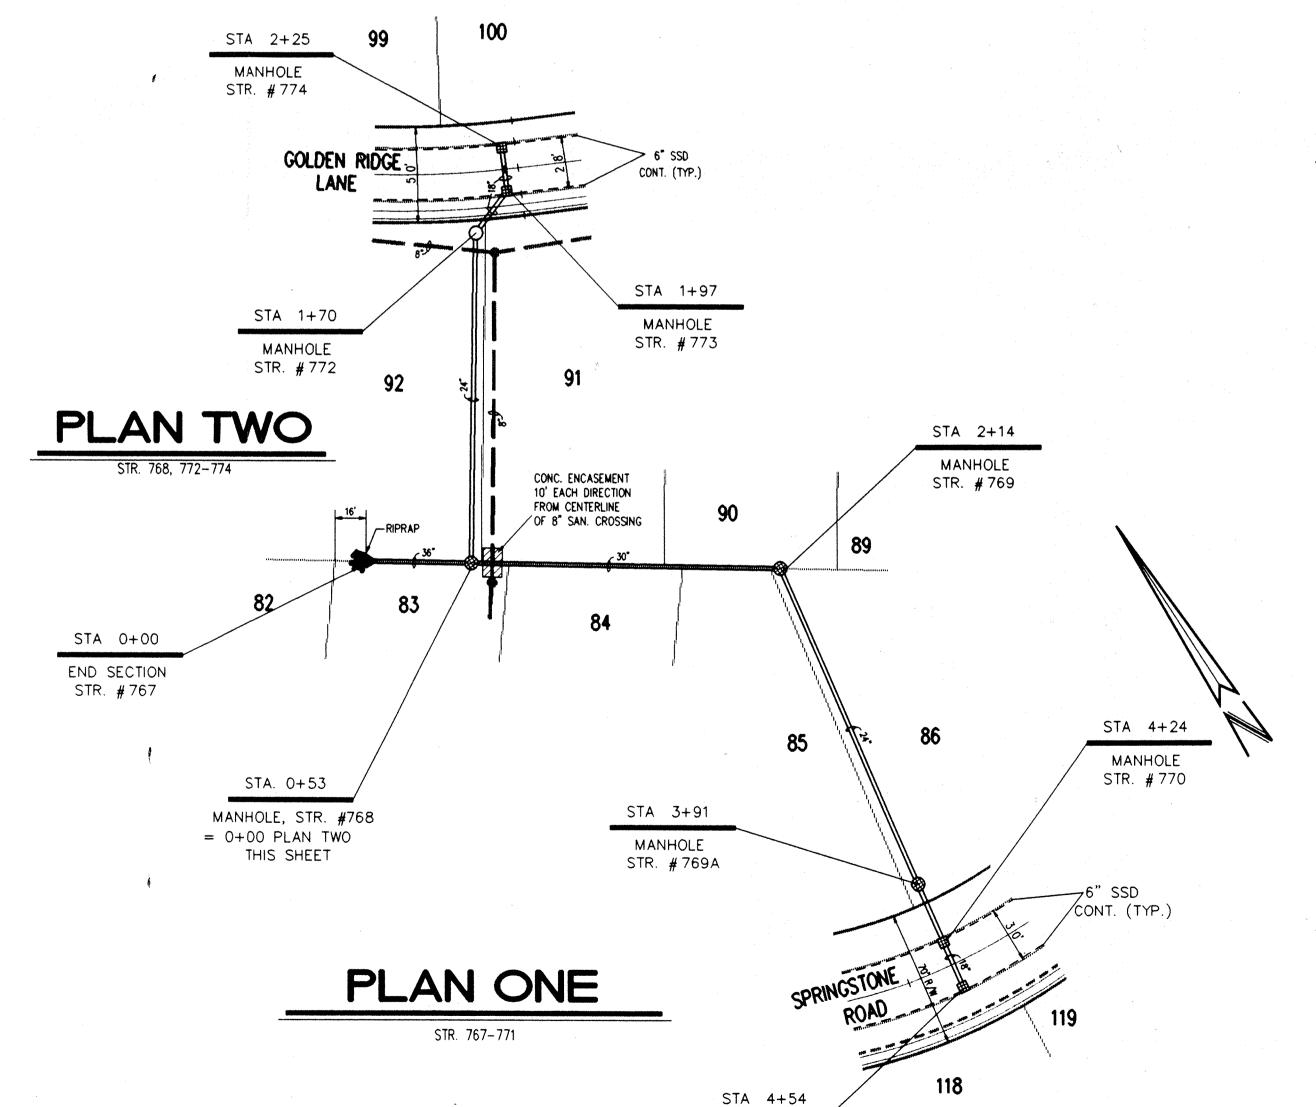


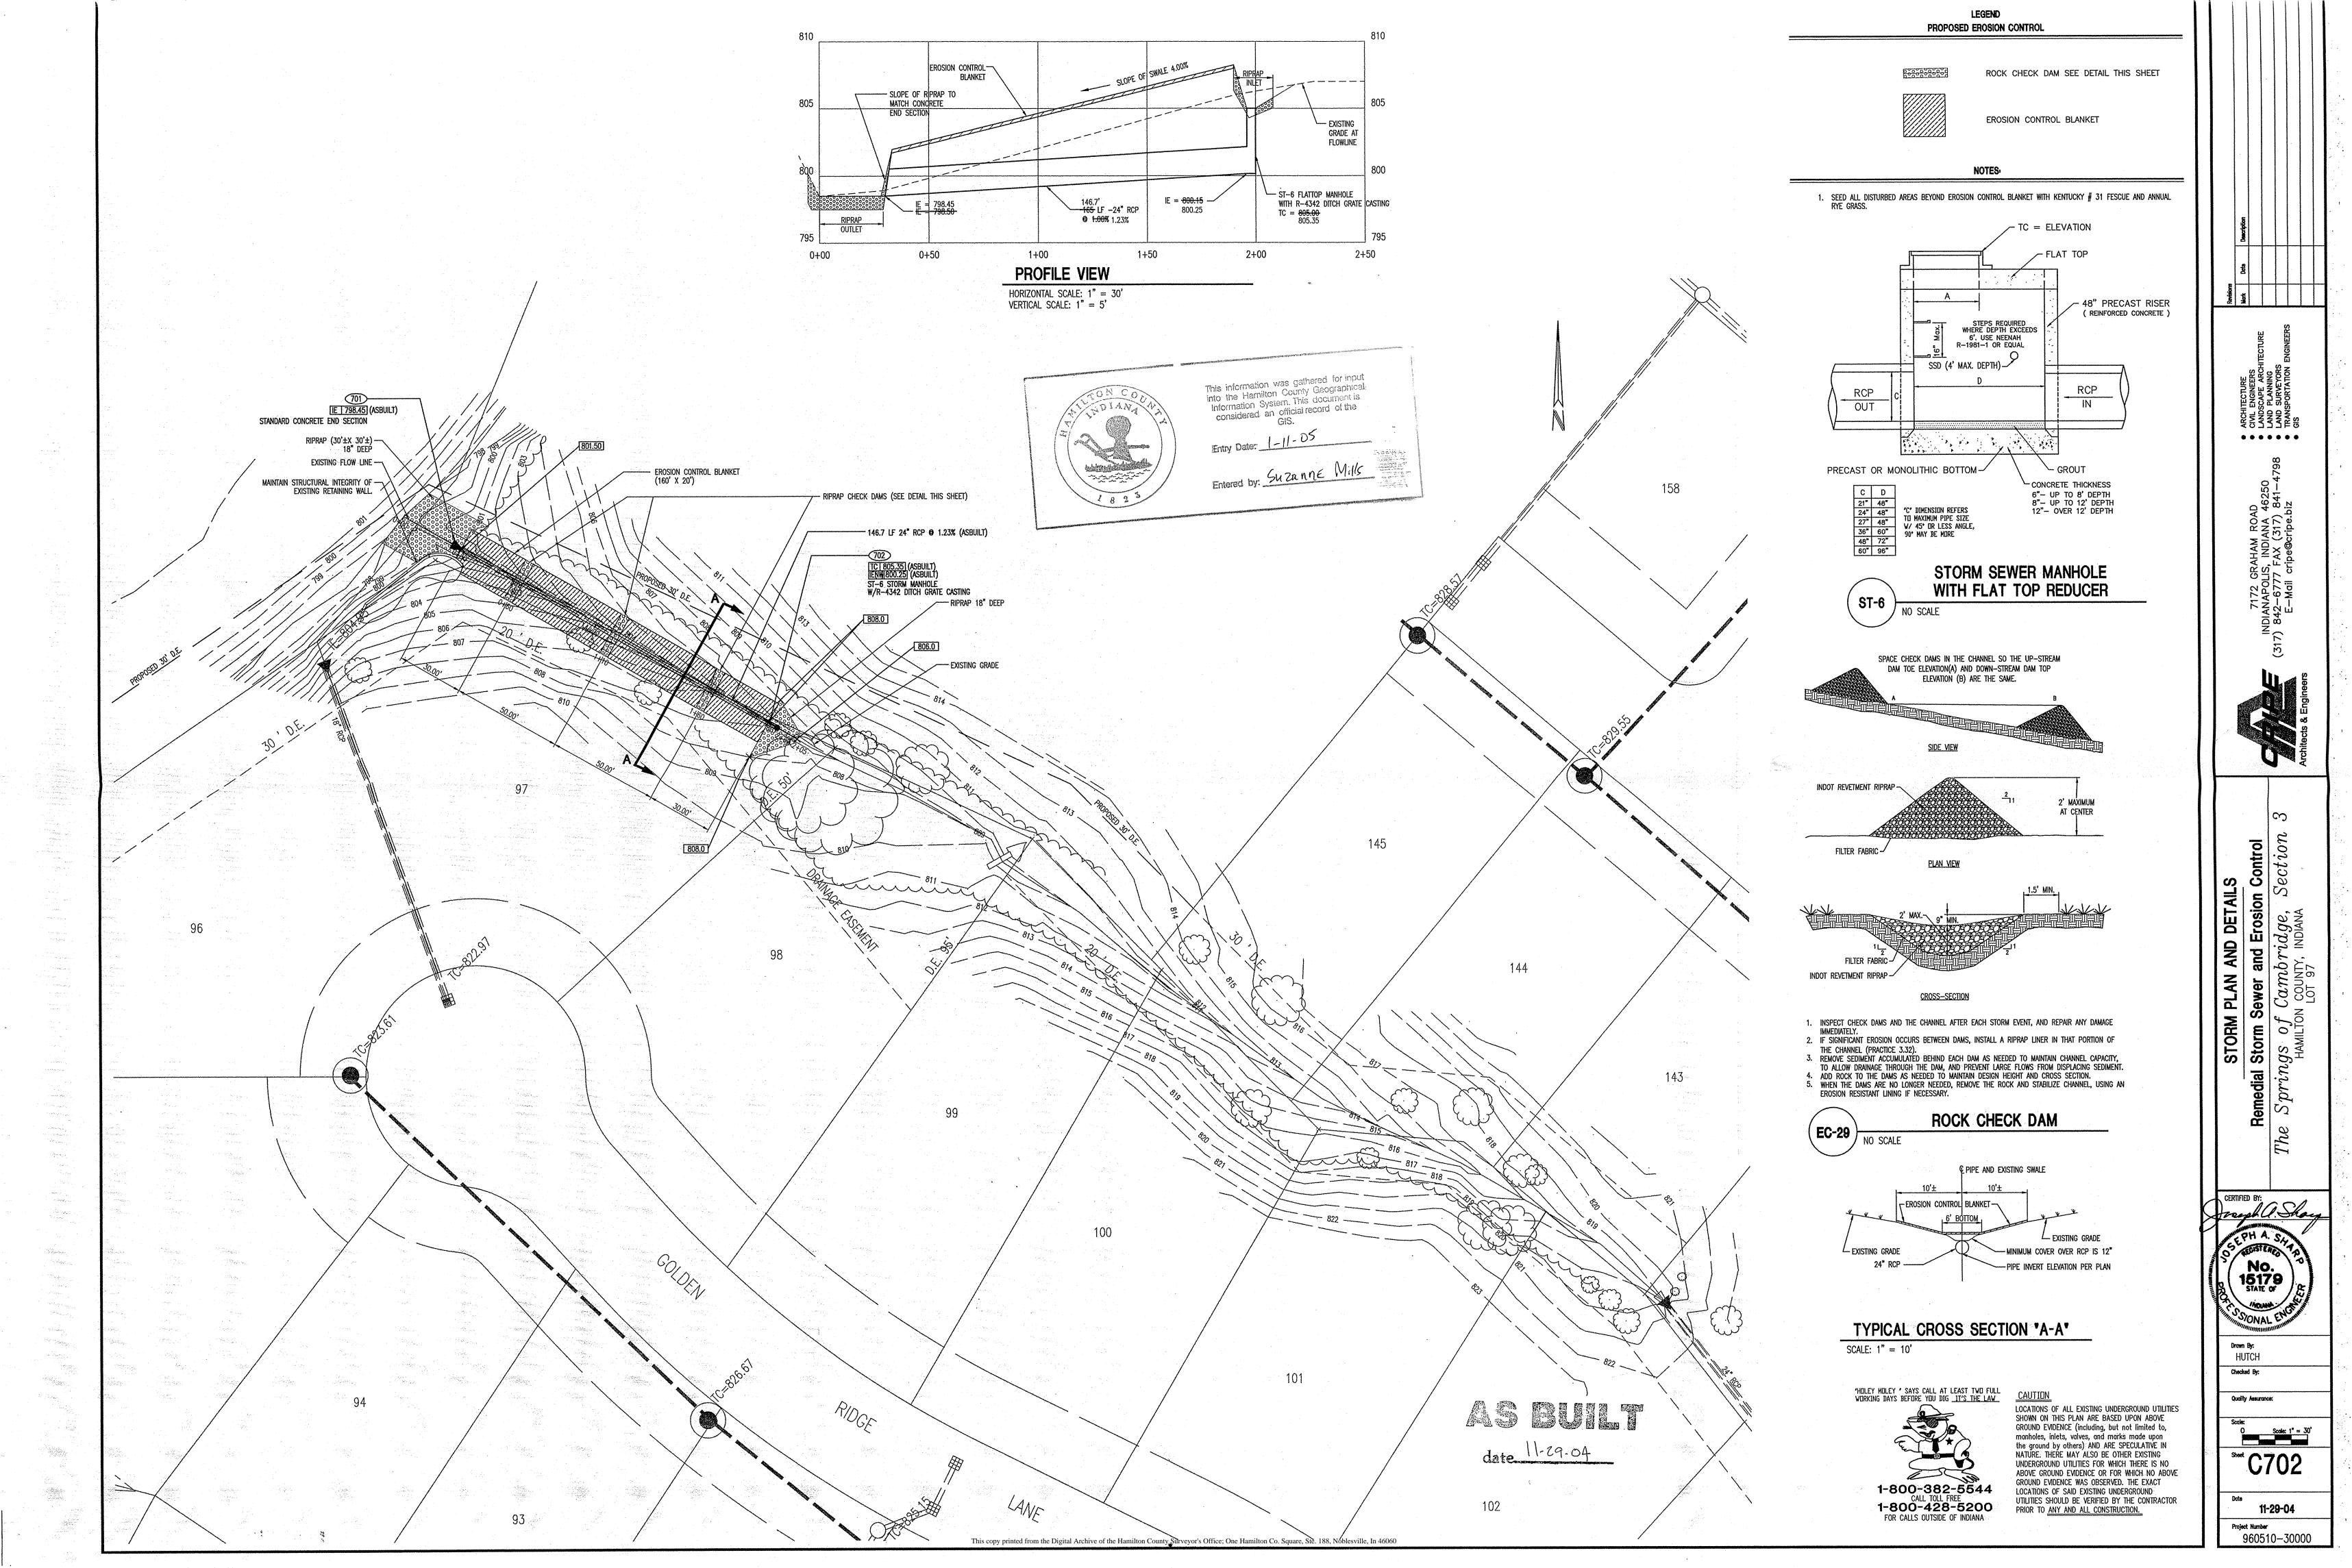

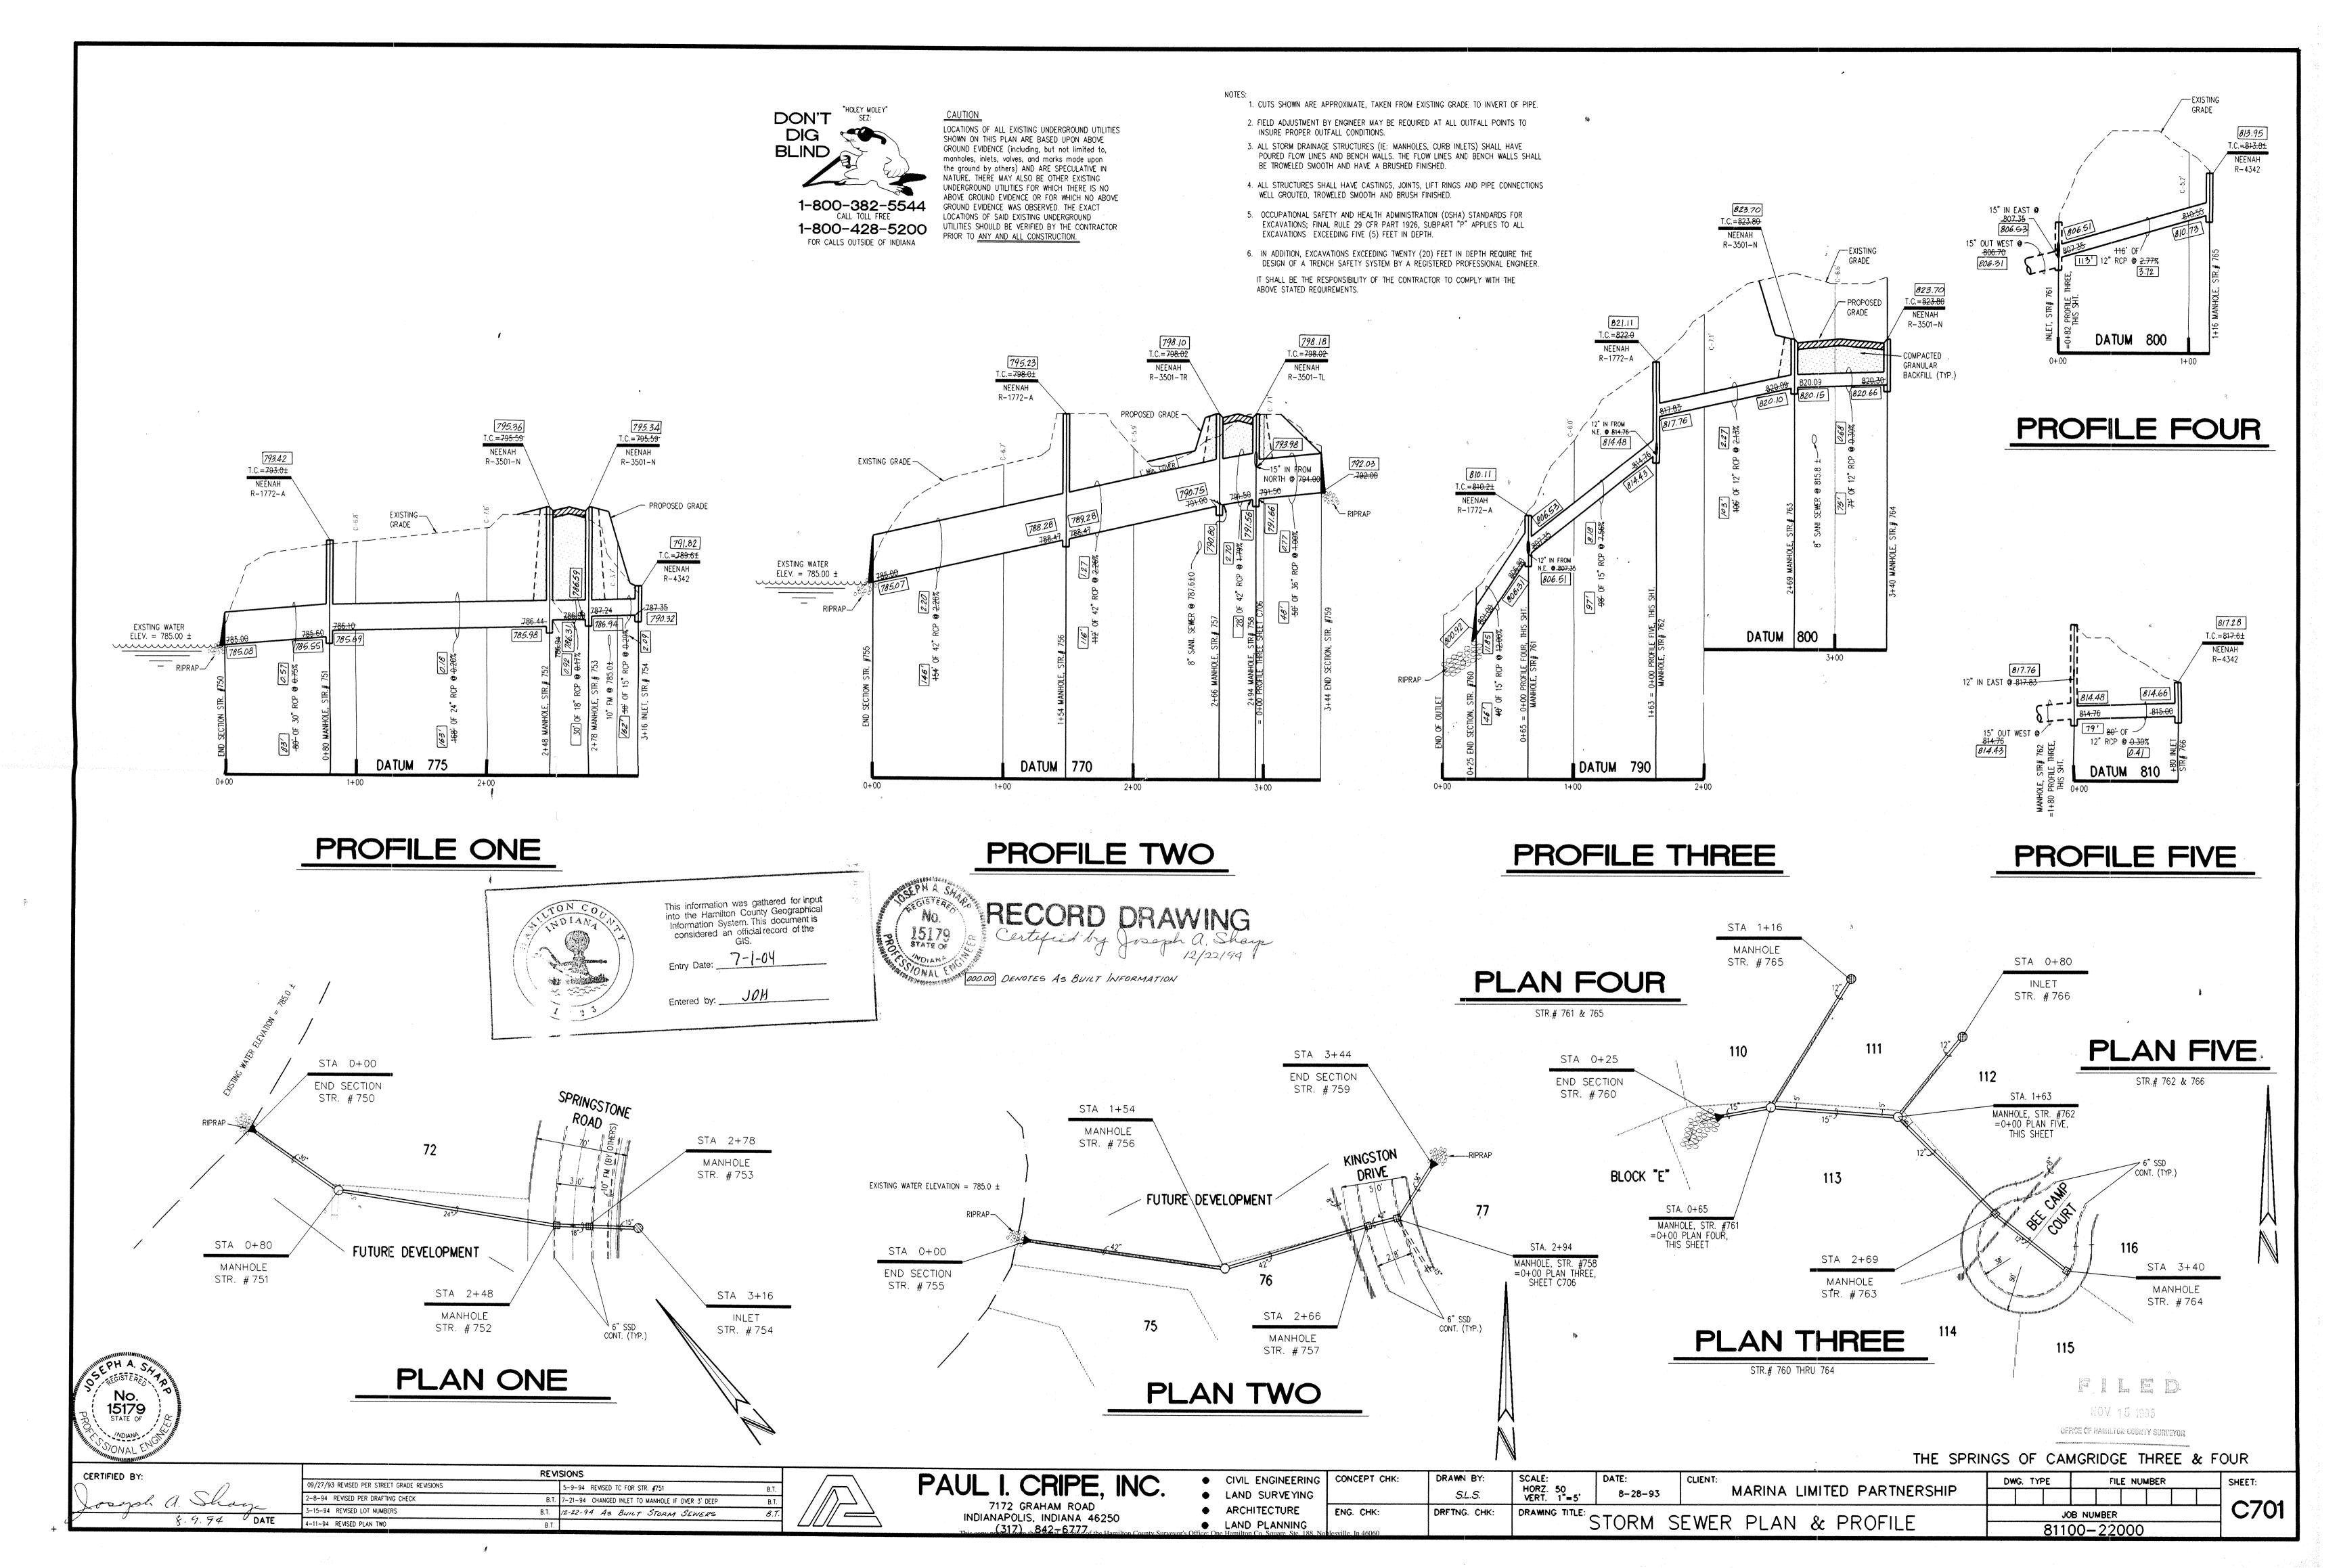


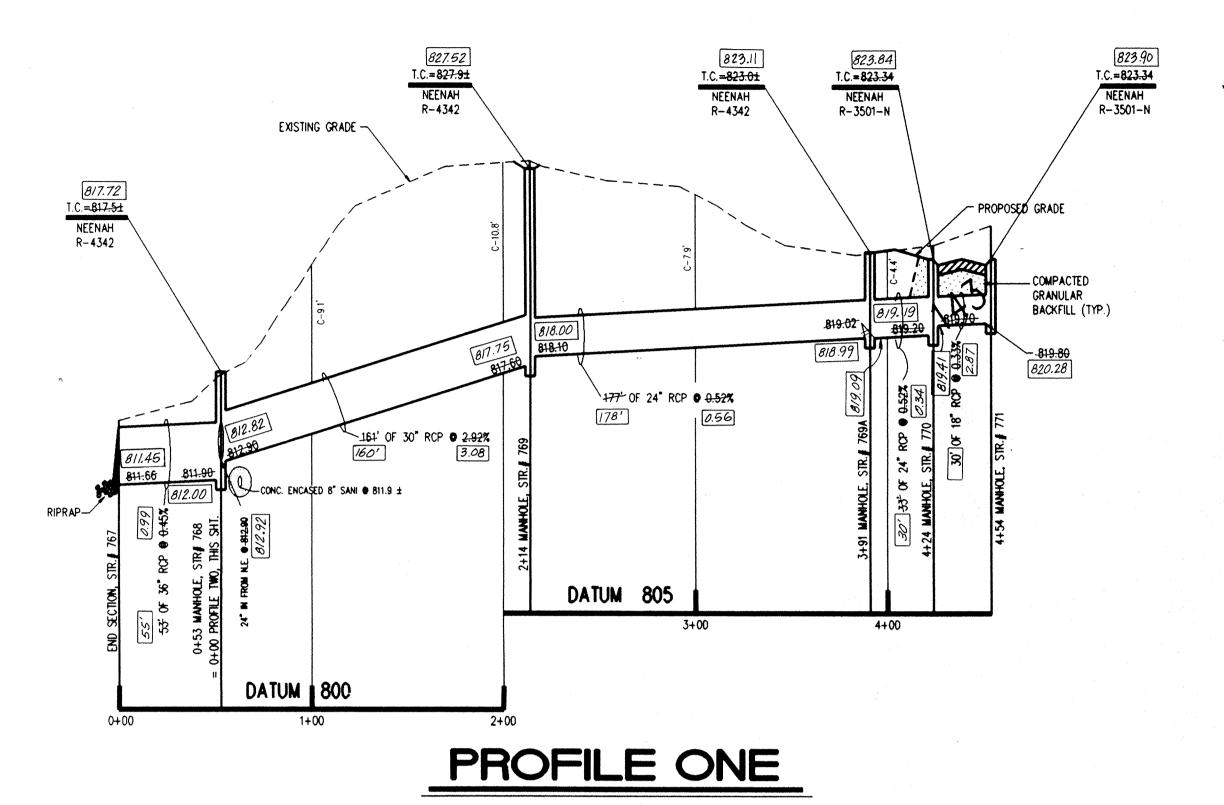PROFILE TWO

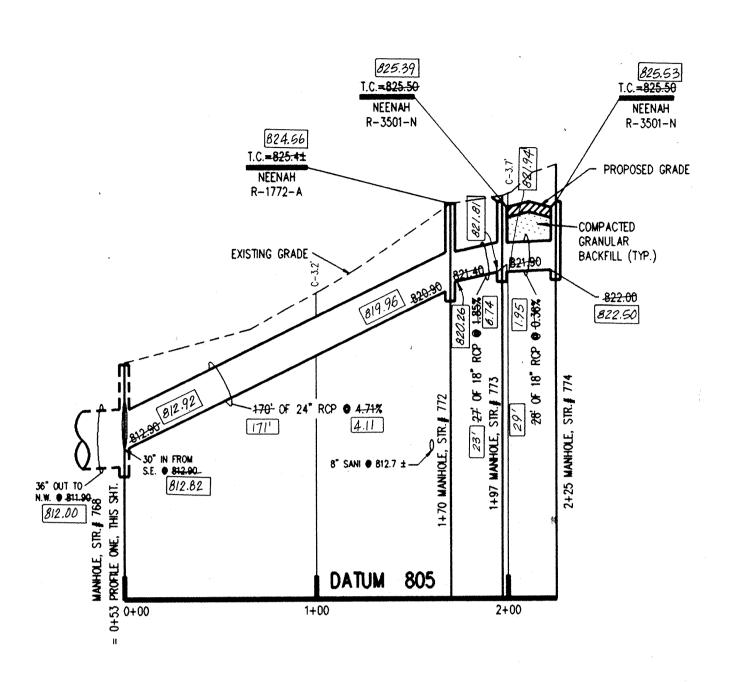PROFILE THREE

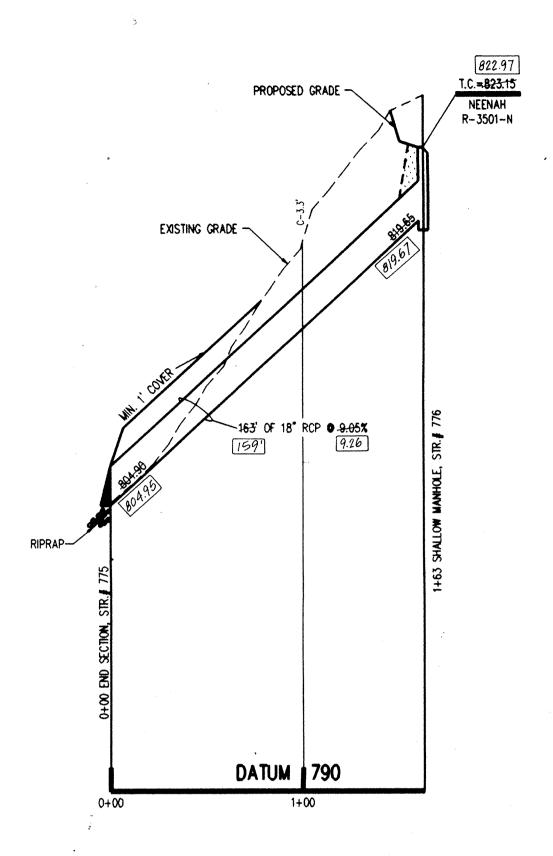

- 1. CUTS SHOWN ARE APPROXIMATE, TAKEN FROM EXISTING GRADE TO INVERT OF PIPE.
- 2. FIELD ADJUSTMENT BY ENGINEER MAY BE REQUIRED AT ALL OUTFALL POINTS TO INSURE PROPER OUTFALL CONDITIONS.
- 3. ALL STORM DRAINAGE STRUCTURES (IE: MANHOLES, CURB INLETS) SHALL HAVE POURED FLOW LINES AND BENCH WALLS. THE FLOW LINES AND BENCH WALLS SHALL BE TROWELED SMOOTH AND HAVE A BRUSHED FINISHED.
- 4. ALL' STRUCTURES SHALL HAVE CASTINGS, JOINTS, LIFT RINGS AND PIPE CONNECTIONS WELL GROUTED, TROWELED SMOOTH AND BRUSH FINISHED.
- 5. OCCUPATIONAL SAFETY AND HEALTH ADMINISTRATION (OSHA) STANDARDS FOR EXCAVATIONS; FINAL RULE 29 CFR PART 1926, SUBPART "P" APPLIES TO ALL EXCAVATIONS EXCEEDING FIVE (5) FEET IN DEPTH.
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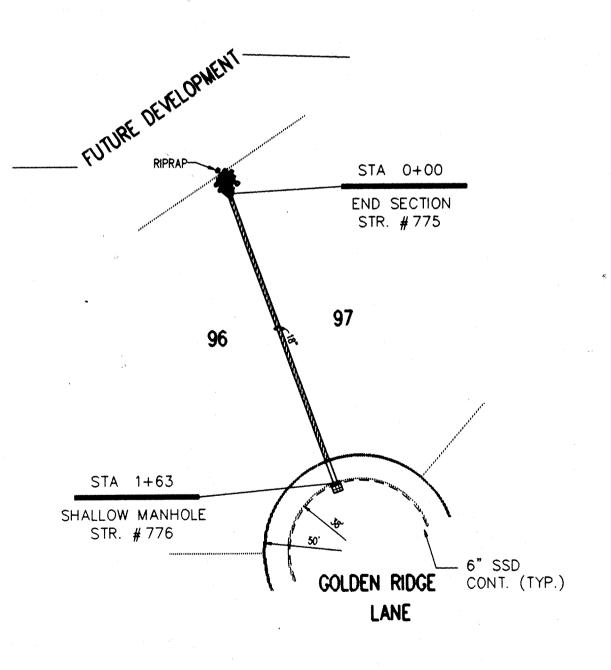


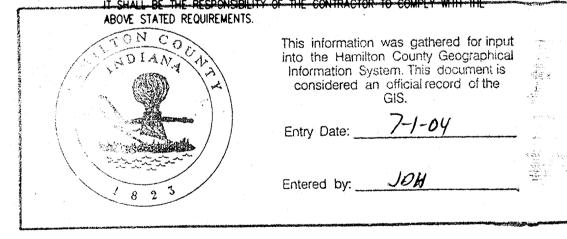

FOR CALLS OUTSIDE OF INDIANA

CAUTION

LOCATIONS OF ALL EXISTING UNDERGROUND UTILITIES SHOWN ON THIS PLAN ARE BASED UPON ABOVE GROUND EVIDENCE (including, but not limited to, manholes, inlets, valves, and marks made upon the ground by others) AND ARE SPECULATIVE IN NATURE. THERE MAY ALSO BE OTHER EXISTING UNDERGROUND UTILITIES FOR WHICH THERE IS NO ABOVE GROUND EVIDENCE OR FOR WHICH NO ABOVE GROUND EVIDENCE WAS OBSERVED. THE EXACT LOCATIONS OF SAID EXISTING UNDERGROUND UTILITIES SHOULD BE VERIFIED BY THE CONTRACTOR PRIOR TO ANY AND ALL CONSTRUCTION.



PLAN THREE

RECORD DRAWING NO. 15179 STATE OF \$000.00 DENOTES AS BUILT INFORMATION OFFICE OF HAMILTON COUNTY SURVEYOR

THE SPRINGS OF CAMBRIDGE SECTIONS THREE & FOUR

REVISIONS CERTIFIED BY: 09/27/93 REVISED PER STREET GRADE REVISIONS -8-94 REVISED PER DRAFTING CHECK B.T. -15-94 REVISED LOT NUMBERS DATE 2-22-94 AS BUILT STORM SEWERS



PAUL I. CRIPE, INC.

MANHOLE

STR. #771


7172 GRAHAM ROAD
INDIANAPOLIS, INDIANA 46250
(31.7) 842 76777 initial Archite


• CIVIL ENGINEERING • LAND SURVEYING • ARCHITECTURE • LAND PLANNING

SCALE: HORZ. 50 VERT. 1"=5" DRAWN BY: CONCEPT CHK: ENG. CHK:


DATE: MARINA LIMITED PARTNERSHIP 08/28/93 DRAWING TITLE: STORM SEWER PLAN & PROFILE

DWG. TYPE FILE NUMBER SHEET: C702 JOB NUMBER 81100-22000

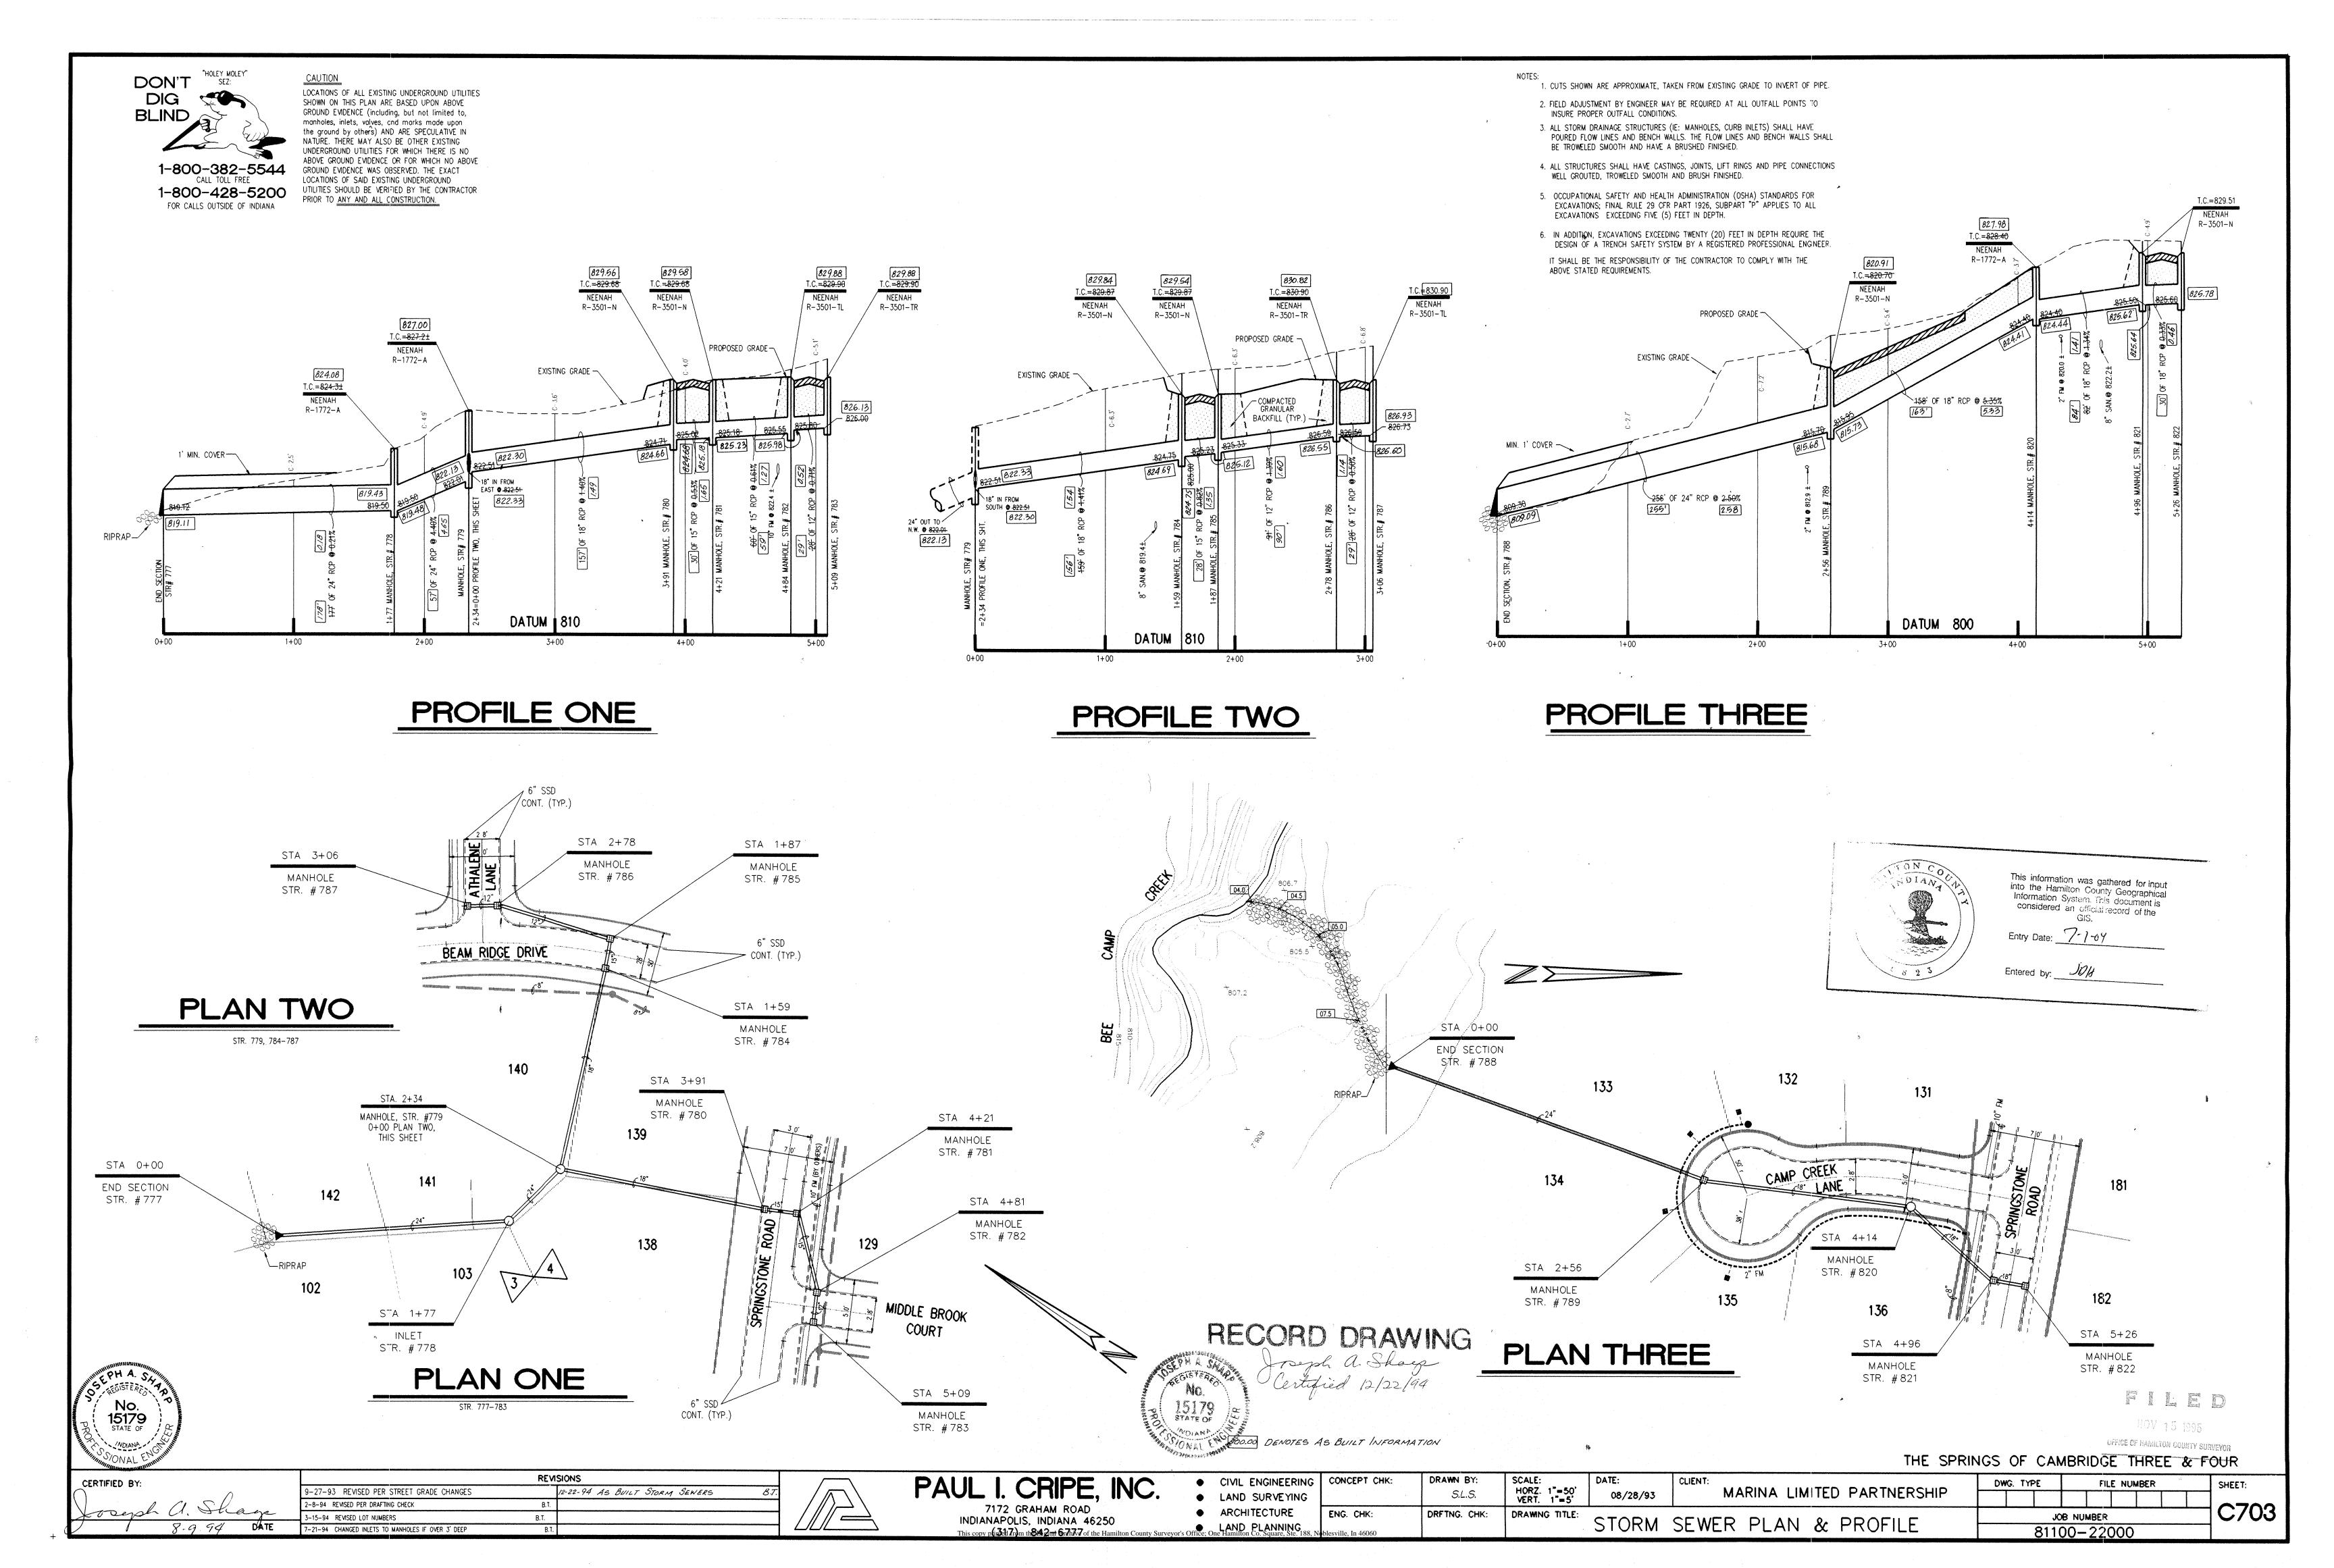

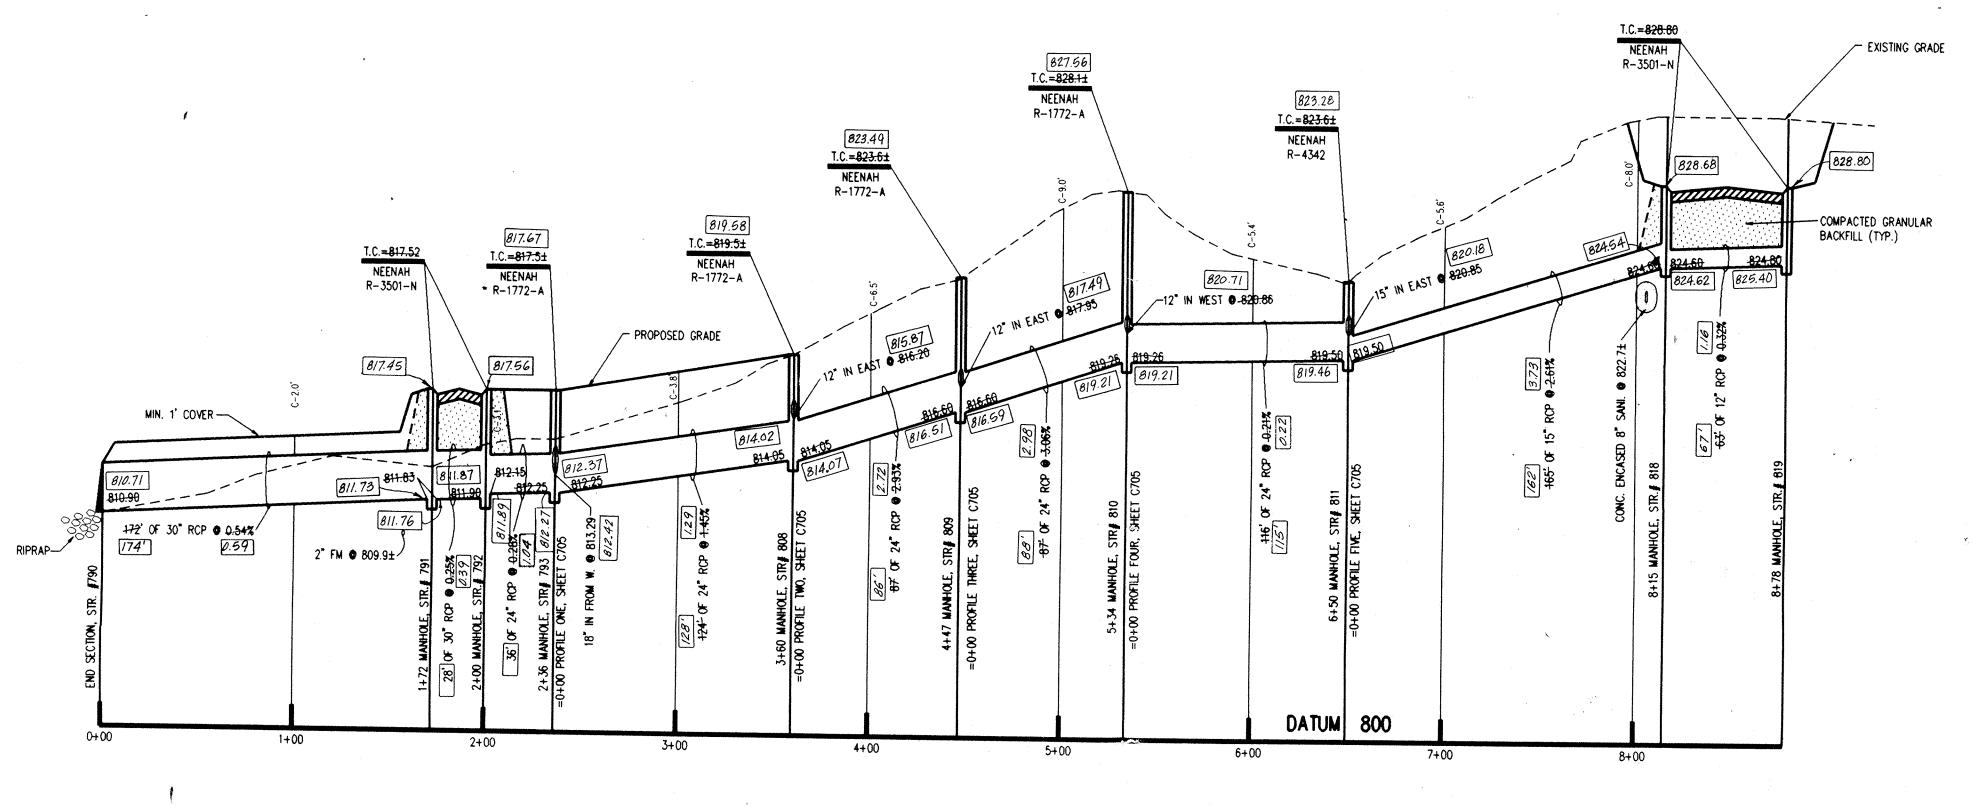


PROFILE ONE

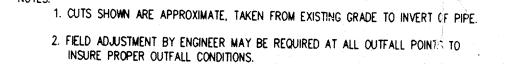

3. ALL STORM DRAINAGE STRUCTURES (IE: MANHOLES, CURB INLETS) SHALL HAVE POURED FLOW LINES AND BENCH WALLS. THE FLOW LINES AND BENCH WALLS SHALL BE TROWELED SMOOTH AND HAVE A BRUSHED FINISHED.

4. ALL STRUCTURES SHALL HAVE CASTINGS, JOINTS, LIFT RINGS AND PIPE CONNECTIONS WELL GROUTED, TROWELED SMOOTH AND BRUSH FINISHED.

5. OCCUPATIONAL SAFETY AND HEALTH ADMINISTRATION (OSHA) STANDARDS FOR EXCAVATIONS; FINAL RULE 29 CFR PART 1926, SUBPART "P" APPLIES TO ALL EXCAVATIONS EXCEEDING FIVE (5) FEET IN DEPTH.

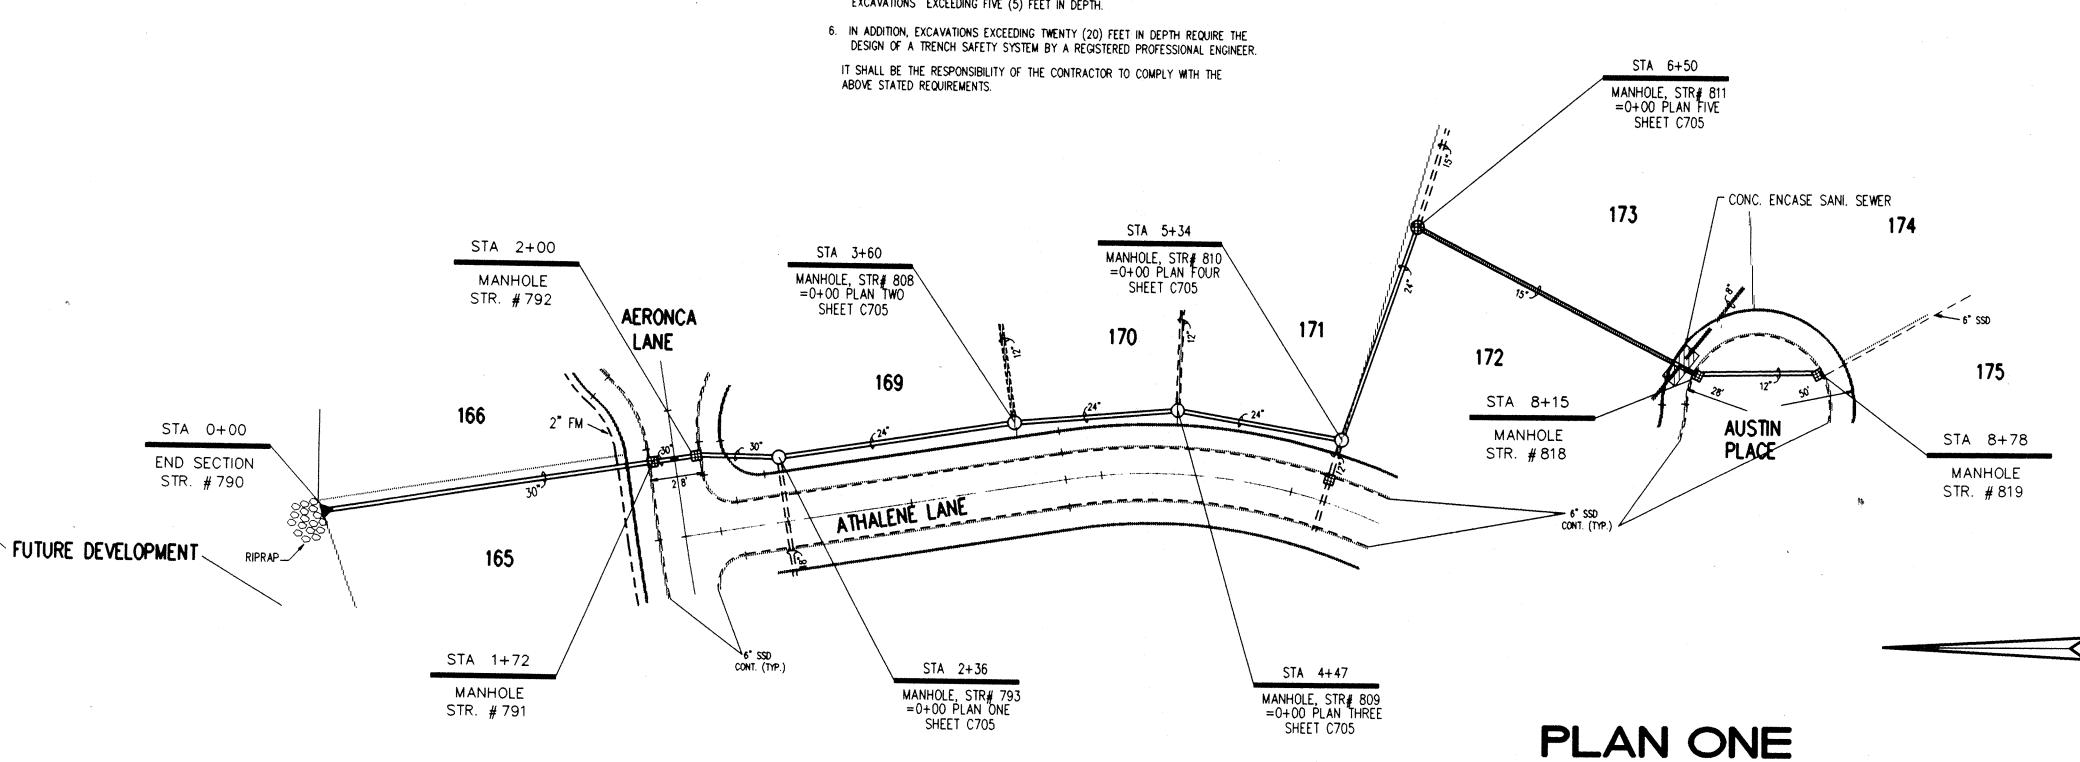




1-800-382-5544 1-800-428-5200 FOR CALLS OUTSIDE OF INDIANA

LOCATIONS OF ALL EXISTING UNDERGROUND UTILITIES SHOWN ON THIS PLAN ARE BASED UPON ABOVE GROUND EVIDENCE (including, but not limited to, manholes, inlets, valves, and marks made upon the ground by others) AND ARE SPECULATIVE IN NATURE. THERE MAY ALSO BE OTHER EXISTING UNDERGROUND UTILITIES FOR WHICH THERE IS NO ABOVE GROUND EVIDENCE OR FOR WHICH NO ABOVE GROUND EVIDENCE WAS OBSERVED. THE EXACT LOCATIONS OF SAID EXISTING UNDERGROUND UTILITIES SHOULD BE VERIFIED BY THE CONTRACTOR PRIOR TO ANY AND ALL CONSTRUCTION.



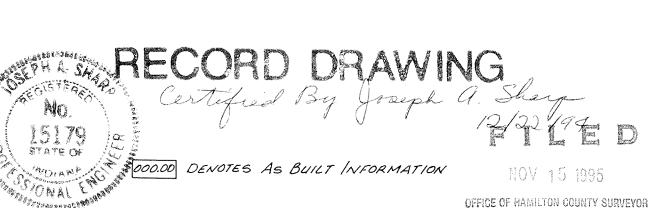

THE SPRINGS OF CAMRIDGE SECTIONS, THREE & FOUR

CERTIFIED BY: REVISIONS 3-27-93 REVISED PER STREET GRADE REVISIONS 2-8-94 REVISED PER DRAFTING CHECK -15-94 REVISED LOT NUMBERS B.T.

12-22-94 AS BUILT STORM SEWERS

8. T.

15179 STATE OF

PAUL I. CRIPE, INC.

 CIVIL ENGINEERING ● LAND SURVEYING 7172 GRAHAM ROAD

ARCHITECTURE
INDIANAPOLIS and Indianapital 16250 f the Hamilton County Surveyor's Office: One Hamilton Co. Square,
(317) 842-6777

CONCEPT CHK: DRAWN BY: ENG. CHK: e. 188, Noblesville, In 46060 DRFTNG. CHK:

SCALE: HORZ. 1"=50' VERT. 1"=5'

MARINA LIMITED PARTNERSHIP 08/28/93 STORM SEWER PLAN & PROFILE

DWG. TYPE JOB NUMBER

SHEET: C704 81100-22000